



2 PSEUDO COLOR PLAN VIEW RENDERING
SCALE: NTS

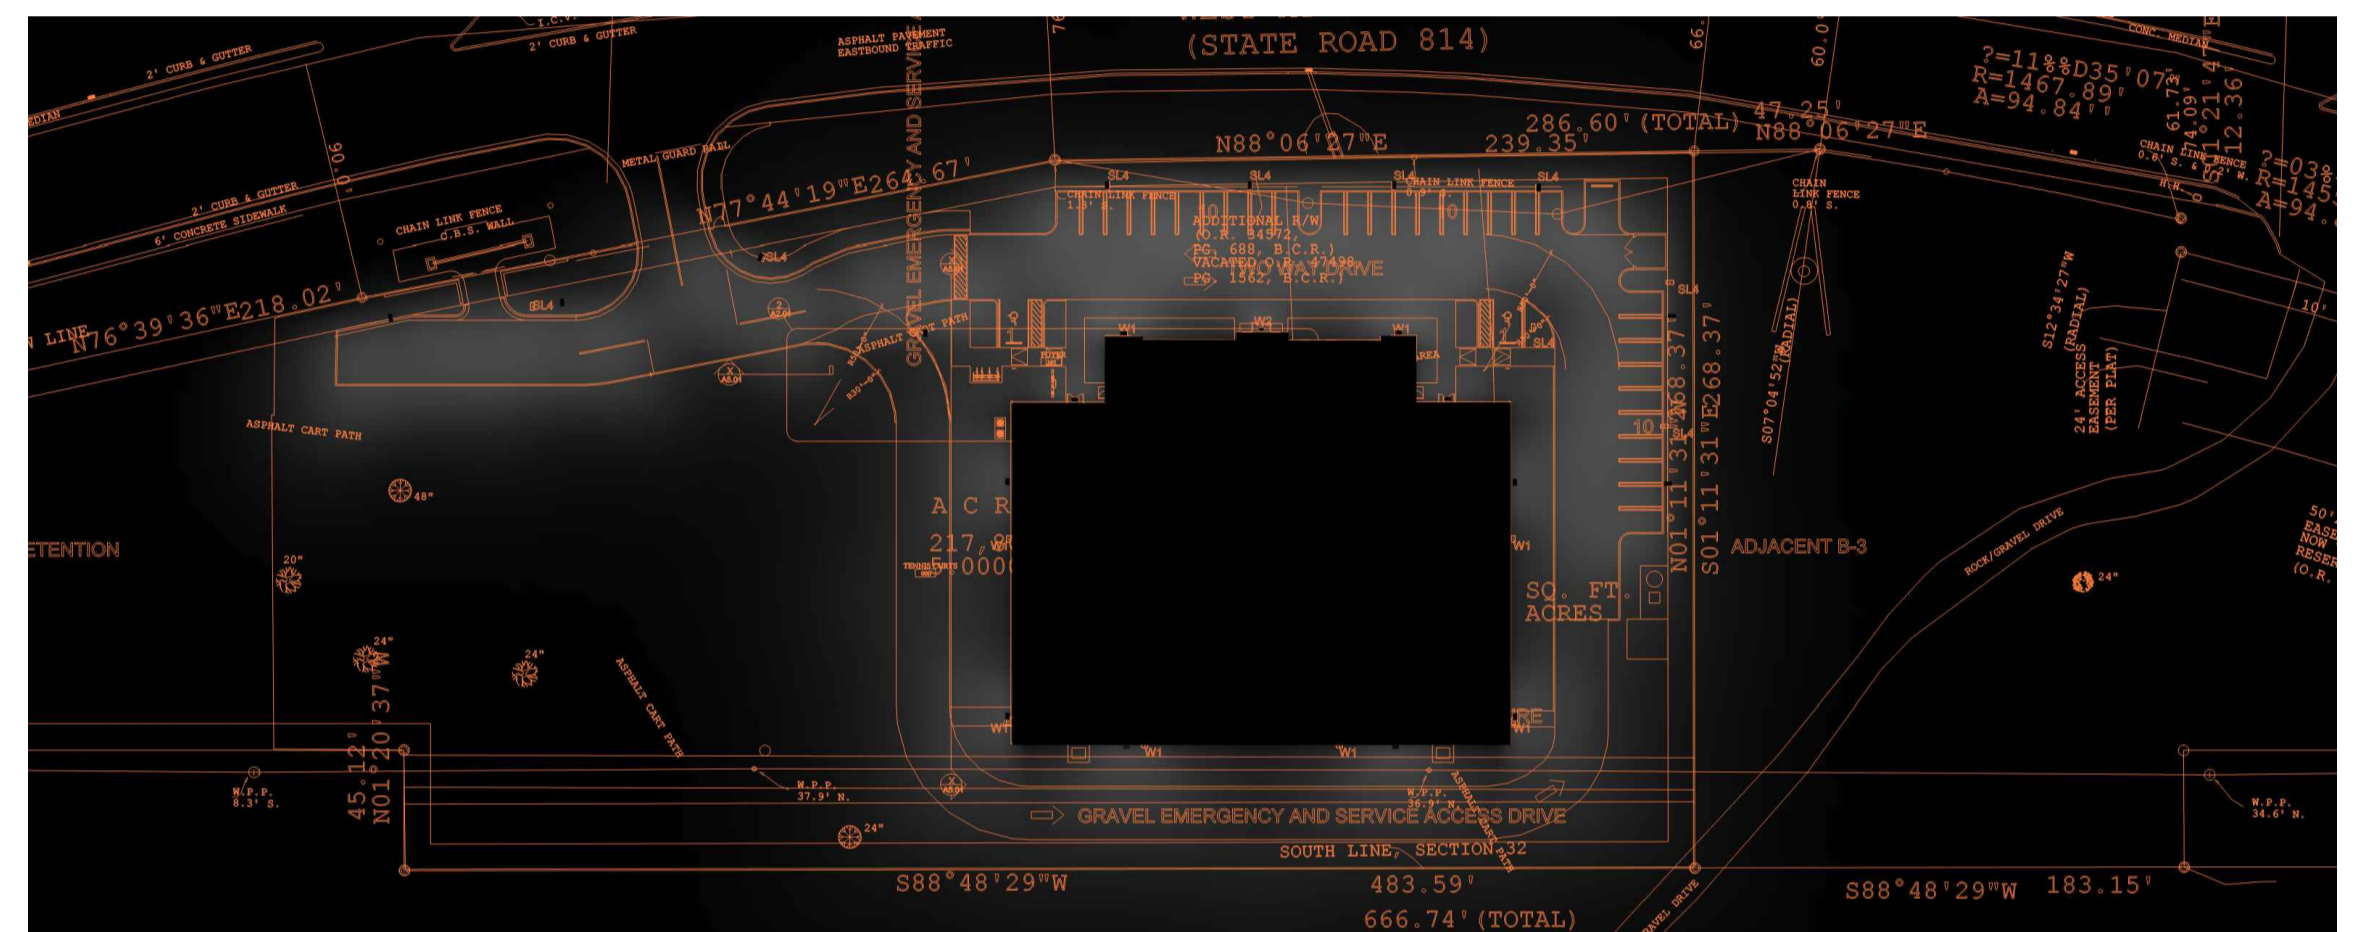

3 GRAYSACLE PLAN VIEW RENDERING

SCALE: NTS

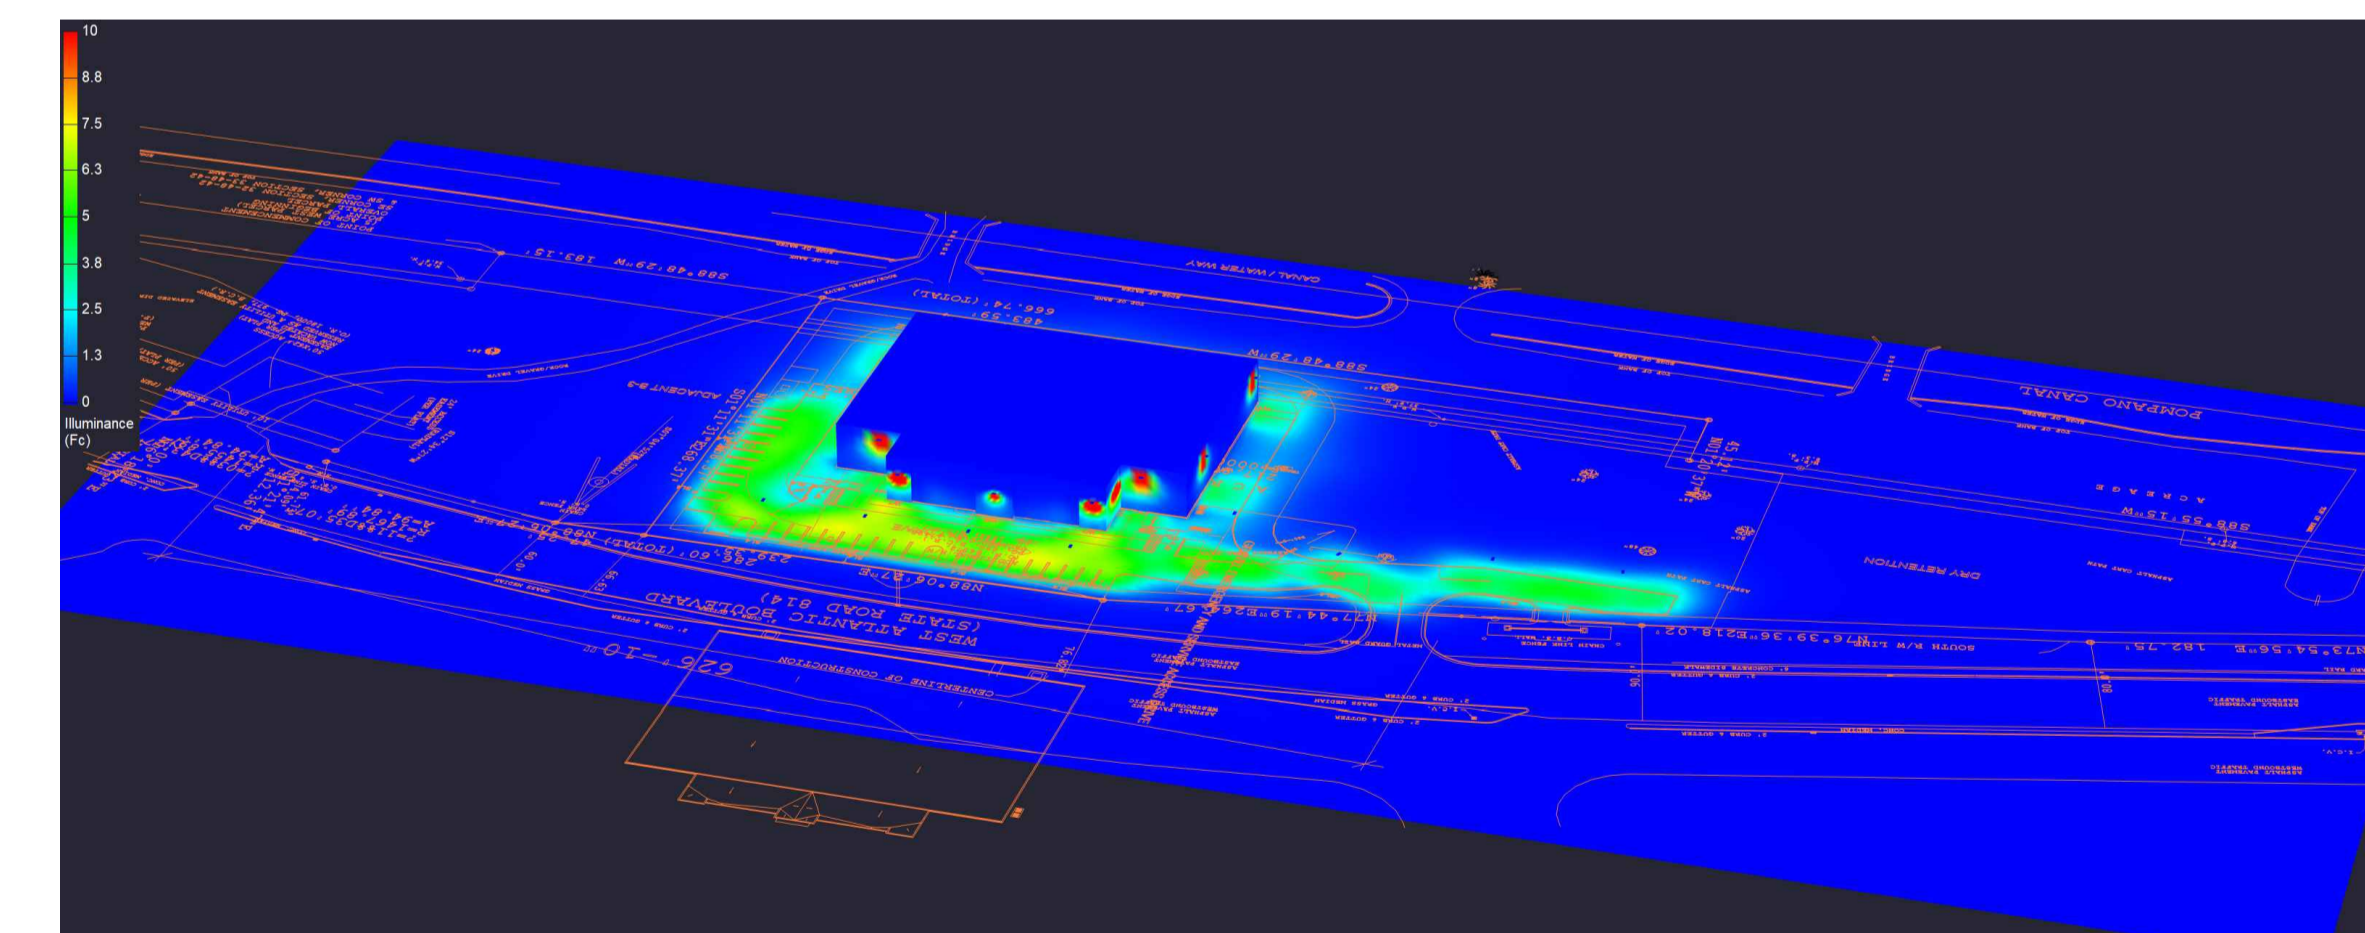

4 ISOMETRIC PSEUDO COLOR RENDERING


SCALE: NTS

All electrical work shall comply with National, State, and Local codes including and not limited to the National Electric Code, NFPA 101 Life Safety Code, ASHREA and /or IECC Energy Codes.

The information contained in this document is proprietary to CBMC Lighting Solutions. This document is prepared for a specific site and incorporates calculations based on data available from the client at this time. By accepting and using this document, the recipient agrees to protect its contents from further dissemination, (other than that within the organization necessary to evaluate such specification) without the written permission of CBMC Lighting Solutions. The contents of this document are not to be reproduced or copied in whole or in part without the written permission of CBMC Lighting Solutions. **copyright © 2024 CBMC Lighting Solutions all rights reserved.**

CBMC • LIGHTING SOLUTIONS

5855 KOPETSKY DR. SUITE G. | INDIANAPOLIS, IN 46217
317-780-8350 | WWW.CBMCINC.COM

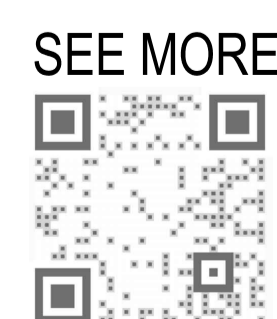

This lighting pattern represents illumination levels calculated from laboratory data taken under controlled conditions in accordance with IESNA approved methods. Actual performance of any manufacturer's luminaire may vary due to variation in electrical voltage, tolerance in lamps and LED lumen package, location adjustments, and other variable field conditions.

Contractor to check and verify all dimensions on site before commencing any work shown.

National Lighting Program Vendor
For pricing and technical assistance contact:
CBMC INC
317-626-1590
Pete Miller - Program Manager- pmiller@cbmcinc.com
Jennifer Karesh-Project Manager - jkaresh@cbmcinc.com
William Proctor - Project Engineer - wproctor@cbmcinc.com

<p>DRAWING INDEX:</p> <p>SL1: SITE LIGHTING PLAN AND RENDERINGS</p> <p>SL2: PHOTOMETRY</p> <p>SL3: LIGHTING CONTROLS AND DETAILS</p>

FLORIDA INDOOR TENNIS
Lighting Plan & Renderings
POMPANO BEACH, FLORIDA

Scale:	NTS	Project No:	CE23498-SL-R3	Revision 3
Date:	8/19/24	Drawing No:	SL1	
Drawn By:	WP			
Checked By:	PM / JK			

SL1

3